


ENGINEERING NOTES:
 THERE HAS NOT BEEN ANY STRUCTURAL, MECHANICAL, ELECTRICAL, OR SITE ENGINEERING PERFORMED FOR THIS PROJECT UNLESS OTHERWISE NOTED.
 IT SHALL BE THE RESPONSIBILITY OF OTHERS TO OBTAIN DESIGN DATA FROM A LICENSED ENGINEER FOR THESE SYSTEMS. ENGINEERING SHALL CONFORM WITH ALL APPLICABLE LOCAL AND/OR STATE BUILDING CODES AND REGULATIONS.


CONSTRUCTION NOTES:
 - ALL WOOD TO BE WESTERN RED CEDAR SMOOTH FINISHED #2 GRADE UNLESS OTHERWISE NOTED.
 - ALL HARDWARE TO BE HOT DIP GALVANIZED, OR STAINLESS STEEL UNLESS OTHERWISE NOTED.
 - ALL SCREWS TO BE #10, LENGTH PER DRAWING, OR AS NOTED.
 - ALL CONCRETE TO BE 3,000 PSI MINIMUM
 - ATTACH ROOF BOARDS TO EACH FRAMING MEMBER w/
 (3) 1/2" CROWN x 2 1/2" LEG x 16 GAUGE STAPLES

BUILDING CODES:
 ALL CONSTRUCTION SHALL COMPLY WITH THE REQUIREMENTS OF ANY AND ALL APPLICABLE STATE COUNTY AND LOCAL BUILDING CODES OR REGULATIONS

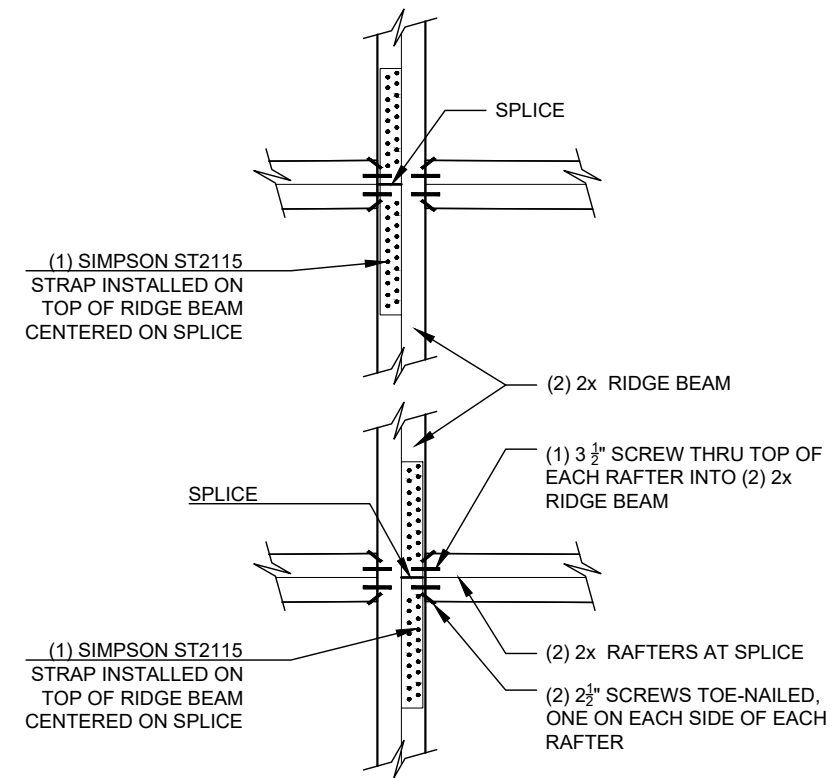


NOTE: PLEASE ENSURE SPLICES ARE ON OPPOSITE END AND OPPOSITE SIDES OF RIDGE BEAM, AS ILLUSTRATED


RIDGE BEAM DETAIL IF SPLICED
 SCALE 1'-0"=1'-0"

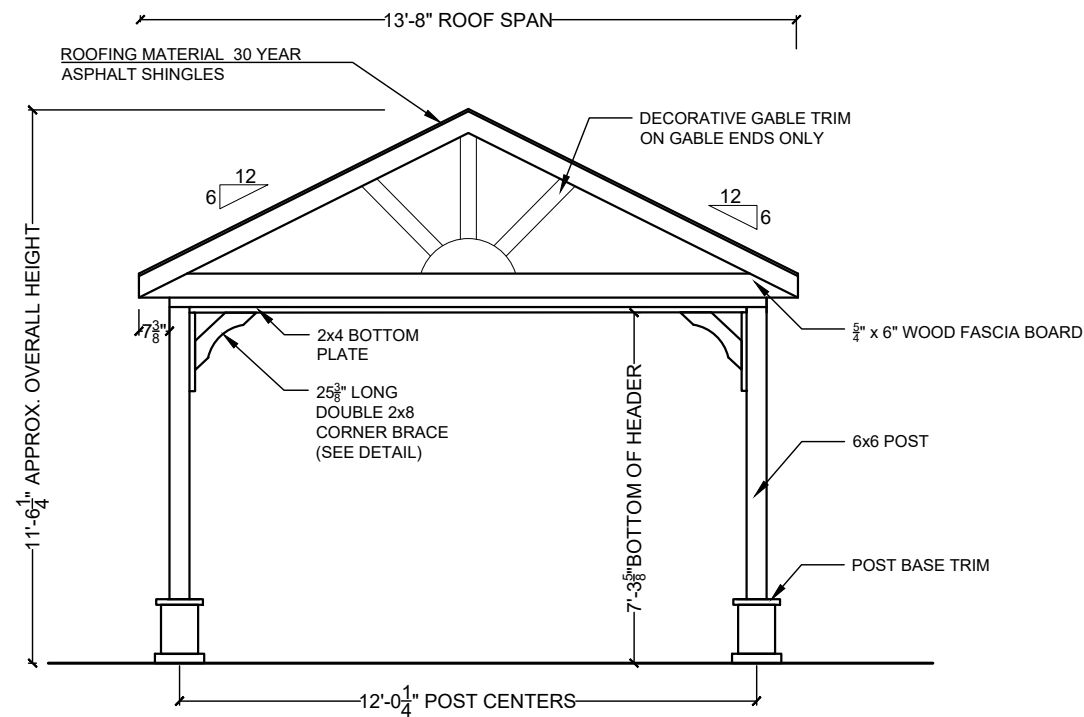


ELEVATION "A"

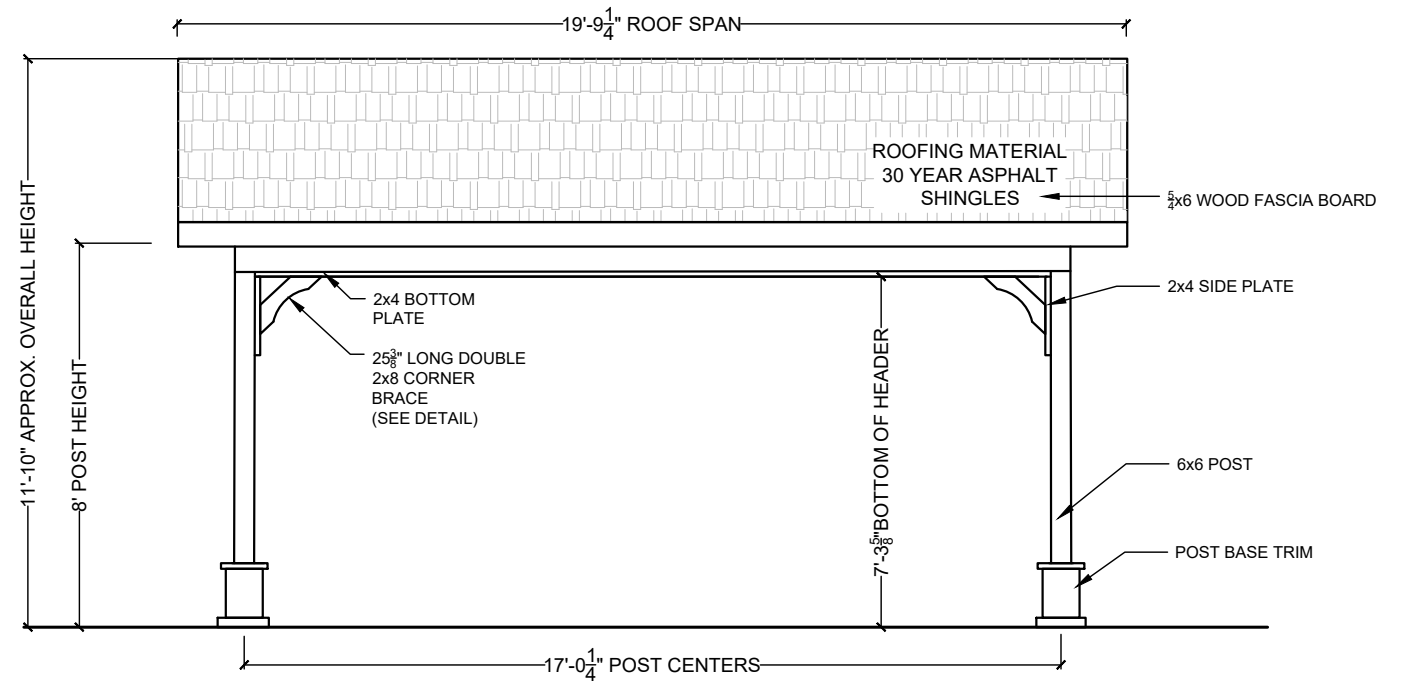


ELEVATION "B"



 PERGOLA KITS USA (800)403-9259 www.pergolakitsusa.com	SITE ADDRESS: SMOOTH WOOD GABLE STANDARD TEMPLATE	13' x 18' OPEN GABLE PAVILION	
		DATE 02/19/2025	SCALE 1/4" = 1'-0"
		SHEET NO. 1 OF 2	

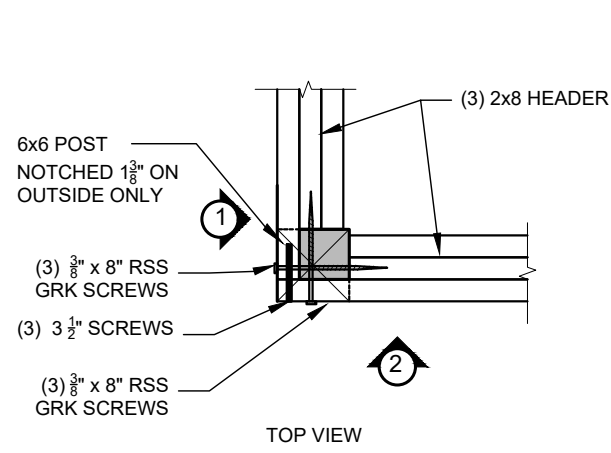


HEADER TO POST CONNECTION DETAIL
NO SCALE

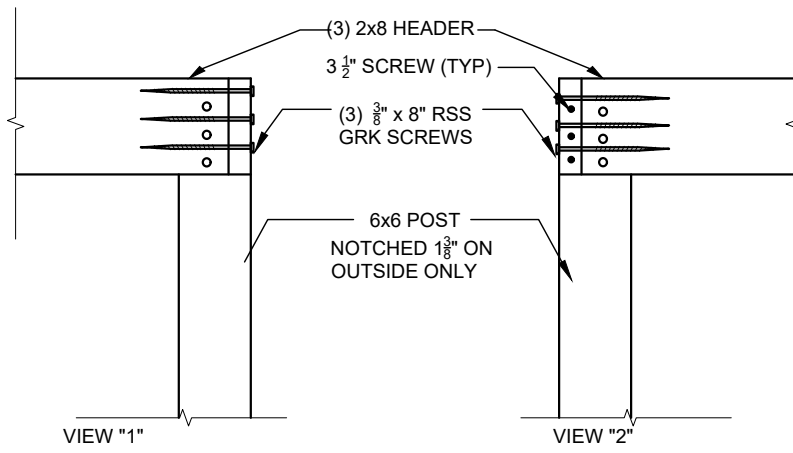


STEEL L-BRACKET DETAIL
NO SCALE

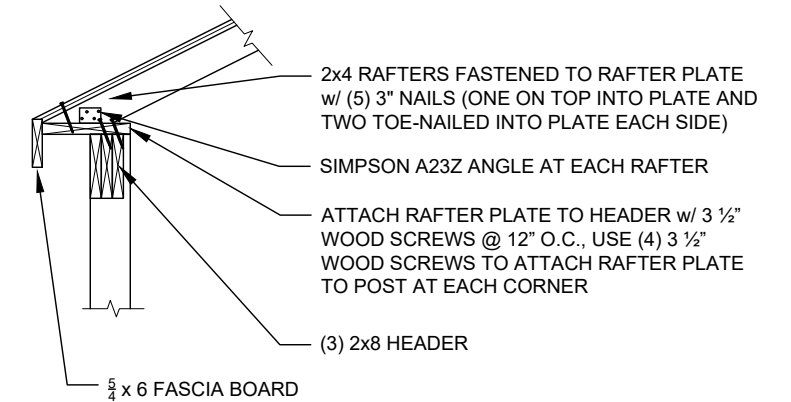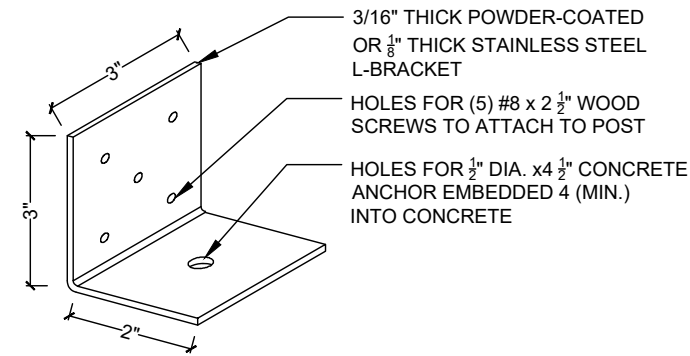


RAFTER CONNECTION DETAIL
SCALE 1/2"=1'-0"

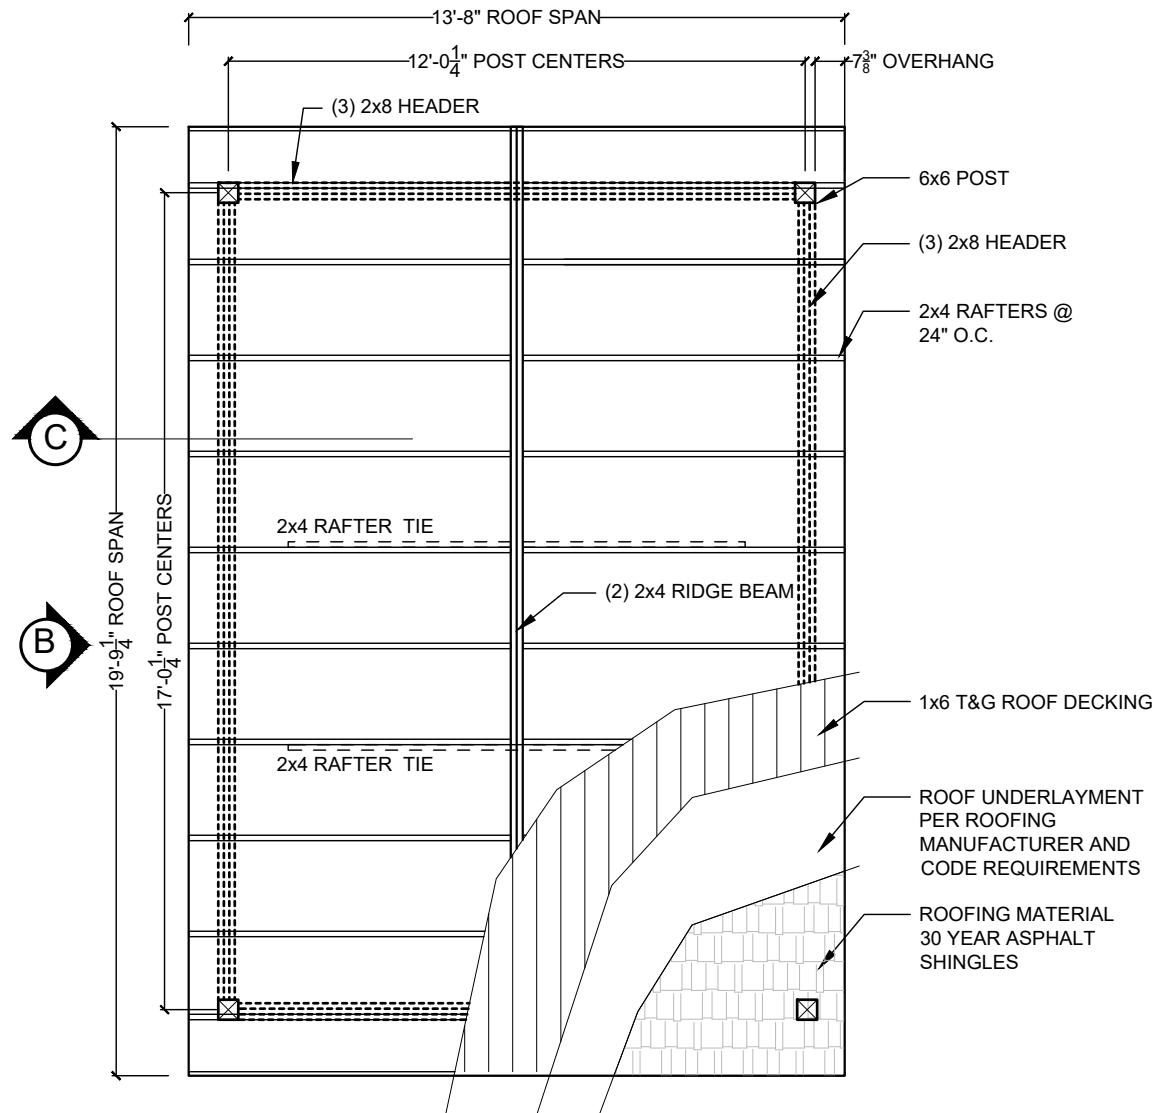

ROOF FRAMING PLAN
SCALE 1/4"=1'-0"

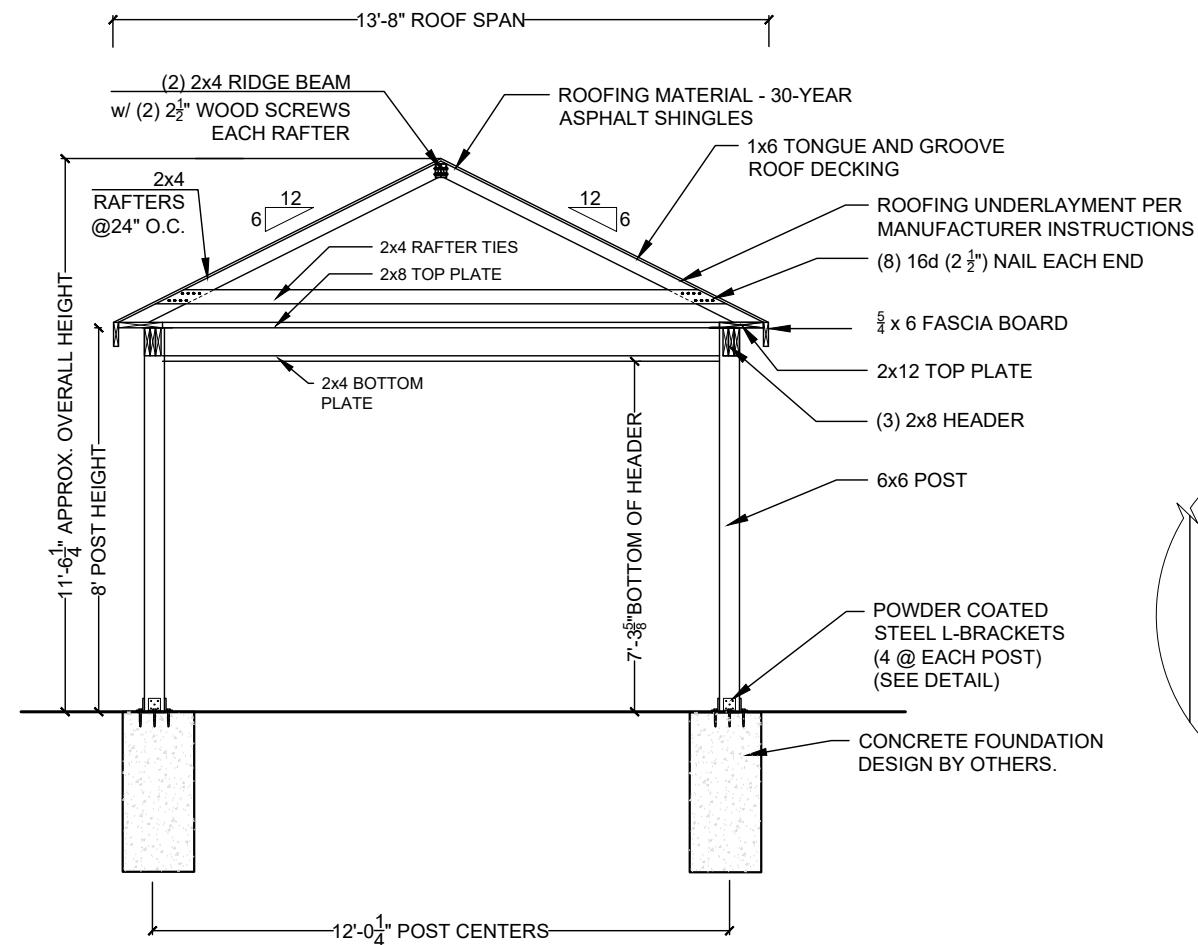

SECTION "C"
SCALE 1/4"=1'-0"

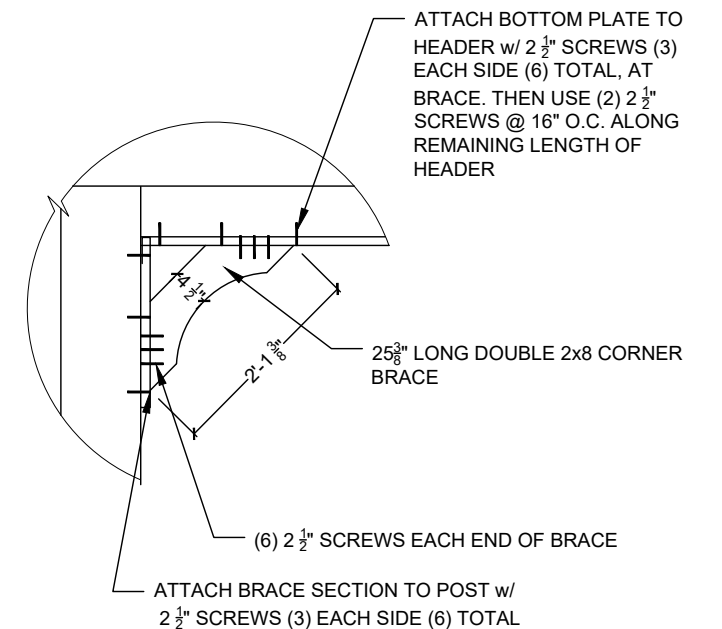

DOUBLE 2x8 BRACE DETAIL
SCALE 1/2"=1'-0"



PERGOLA KITS USA
(800)403-9259
www.pergolakitsusa.com

SITE ADDRESS:

SMOOTH WOOD GABLE
STANDARD TEMPLATE

13' x 18' OPEN GABLE PAVILION

DATE 02/19/2025

SCALE: AS NOTED

SHEET NO. 2 OF 2